

DEMOLITION GENERAL NOTES SHEET GENERAL NOTES WHERE EQUIPMENT AND/OR FIXTURES ARE INDICATED TO BE REMOVED. ALL SERVICES, EQUIPMENT, ETC., SHOWN ON PLANS ARE NEW AND SHALL BE FURNISHED UNDER THIS CONTRACTOR UNLESS OTHERWISE THE EXISTING SERVICES SHALL BE CAPPED AND CONCEALED. ALL ABANDONED BRANCH SERVICES WHICH SERVE ABOVE EQUIPMENT, ETC., SHALL BE REMOVED BACK TO THE MAINS AND CAPPED, UNLESS OTHERWISE INDICATED. IN GENERAL, ALL PIPING AND DUCTWORK SHALL BE RUN CONCEALED IN SUSPENDED CEILING SPACES AND IN SHAFTS PROVIDED UNLESS NOTED OR OTHERWISE INDICATED. CERTAIN ROOMS HAVE NO CAP ANY REMAINING PIPE AND/OR DUCT OPENINGS. SUSPENDED CEILINGS, AND PIPING AND DUCTWORK IN THESE ROOMS THIS CONTRACTOR SHALL BE RESPONSIBLE FOR ALL PATCHING AND IS TO BE EXPOSED. PAINTING TO MATCH EXISTING WALLS, FLOORS, AND CEILINGS. ALL PIPING AND DUCTWORK IS INTENDED TO BE CONCEALED IN WALLS AND PARTITIONS UNLESS SPECIFICALLY NOTED OTHERWISE. SOME ITEMS MAY APPEAR NOT TO BE CONCEALED DUE TO DIGITAL REGISTRATION AND ALIGNMENT ISSUES ASSOCIATED WITH THE DUPLICATION PROCESS. COOPERATE WITH THE OTHER TRADES TO AVOID ANY CONFLICTS BETWEEN PIPING, DUCTWORK, ELECTRICAL WORK, ETC. MECHANICAL SHEET INDEX ALL DETAILS, SCHEMATICS, DIAGRAMS, ETC., DESIGNATE GENERAL ARRANGEMENT ONLY. 1-M001 SYMBOLS, ABBREVIATIONS, GENERAL NOTES FOR DETAILS, EQUIPMENT CONNECTIONS, AND PIPE SIZES NOT SHOWN 1-MH-101 BUILDING 96 AND 148 MECHANICAL PLANS ON FLOOR PLANS, REFER TO ELEVATIONS, DETAILS, RISERS AND 1-MH-102 BUILDING 110 AND 147 MECHANICAL PLANS SCHEDULES. 1-MH-103 BUILDING 53, 145 & 148 MECHANICAL PLANS THIS CONTRACTOR IS RESPONSIBLE FOR ALL SLEEVES AND/OR 1-ME601 MECHANICAL SCHEDULES OPENINGS WHERE REQUIRED TO RUN PIPES AND DUCTS THROUGH FOUNDATIONS, FLOOR SLABS, WALLS, BRIDGING AND BEAMS EXCEPT WHERE OTHERWISE INDICATED. THE CONTRACTOR SHALL VISIT THE SITE AND VERIFY ALL EXISTING CONDITIONS AND DIMENSIONS. NOTIFY THE A/E IMMEDIATELY OF ANY DISCREPANCIES. WHERE NEW SERVICES ARE SHOWN CONNECTING TO EXISTING, VERIFY EXACT LOCATION AND SIZE OF EXISTING. ALL EXISTING SERVICES SHALL BE MAINTAINED UNLESS OTHERWISE INDICATED. ALL DUCTS, PIPING, FIXTURES, ETC., WHICH ARE DASHED AND/OR INDICATED BY NOTE ON DEMOLITION PLANS SHALL BE REMOVED. WHERE SHEET METAL HOUSING, PLENUMS AND DUCTWORK ARE FASTENED TO GENERAL CONSTRUCTION. TAKE SPECIAL CARE TO MAKE AN AIRTIGHT SEAL AT THIS POINT. WHERE MATERIAL IS INDICATED TO BE REMOVED, IT SHALL REMAIN THE PROPERTY OF THE OWNER. THIS CONTRACTOR SHALL DISPOSE OF MATERIAL AS DIRECTED BY THE OWNER. . ALL PIPE PENETRATIONS OF RATED WALLS AND FLOORS SHALL BE SLEEVED AND PROPERLY FIRE SEALED. 5. ALL PIPE AND DUCT PENETRATIONS OF SMOKE PARTITION WALLS SHALI BE PROPERLY SEALED TO RESIST THE PASSAGE OF SMOKE AS REQUIRED BY THE LOCAL AUTHORITY. DISRUPTION OF SERVICES AND ACCESSIBILITY NOTES: <u>DISRUPTION OF SERVICES</u>: ALL AREAS SERVED BY H.V.A.C. EQUIPMENT ARE OCCUPIED DAILY. ROOF OPENINGS SHALL NOT BE LEFT OPEN OVE NIGHT. PERMANENT EQUIPMENT SHALL BE SET IN PLACE IMMEDIATELY AFTER THE EXISTING EQUIPMENT IS REMOVED. CONTRACTOR SHALL ANTICIPATE SOME AFTER HOURS AND WEEKEND WORK. ADVANCE WORK AND PREPARATION WILL BE PERFORMED BY THE CONTRACTOR TO KEEF DISRUPTION OF SERVICES TO A MINIMUM. A CONSTRUCTION SCHEDULE SHALL BE PROVIDED TO THE OWNER. REPLACEMENT SCHEDULE SHALL BE CLOSELY COORDINATED WITH THE OWNER NO LESS THAN (2) WEEKS IN ADVANCE. NO WORK SHALL BE PERFORMED PRIOR TO APPROVAL BY ACCESSIBILITY OF VALVES AND CONTROLS: ALL VALVES AND CONTROLS SHALL BE LOCATED AND INSTALLED FOR EASE OF MAINTENANCE AND ACCESS. CONTRACTOR SHALL OBTAIN APPROVAL FROM THE OWNER BEFORE INSTALLING ALL VALVES AND CONTROLS. Project Title Project Number Office of DEPT. OF V.A. (V23) BHHCS 568-11-115 Construction REPAIR & REINSULATE STEAM Building Number PIPING and Facilities Location Drawing Number Management FORT MEADE, SD Department of Veterans Affairs 09-21-2012 SMT Dwg. 2 of 6

ARCHITECT/ENGINEERS:

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1112 N. West Ave. Sioux Falls, SD 57104 phone: (605) 336-1160 fax: (605) 336-7926 www.teamtsp.com To Solve. To Excel. Together. TSP PROJECT #04121063 Drawing Title SYMBOLS, ABBREVIATIONS, GENERAL **NOTES** Approved: Project Director


VA FORM 08-6231


CONSULTANTS:


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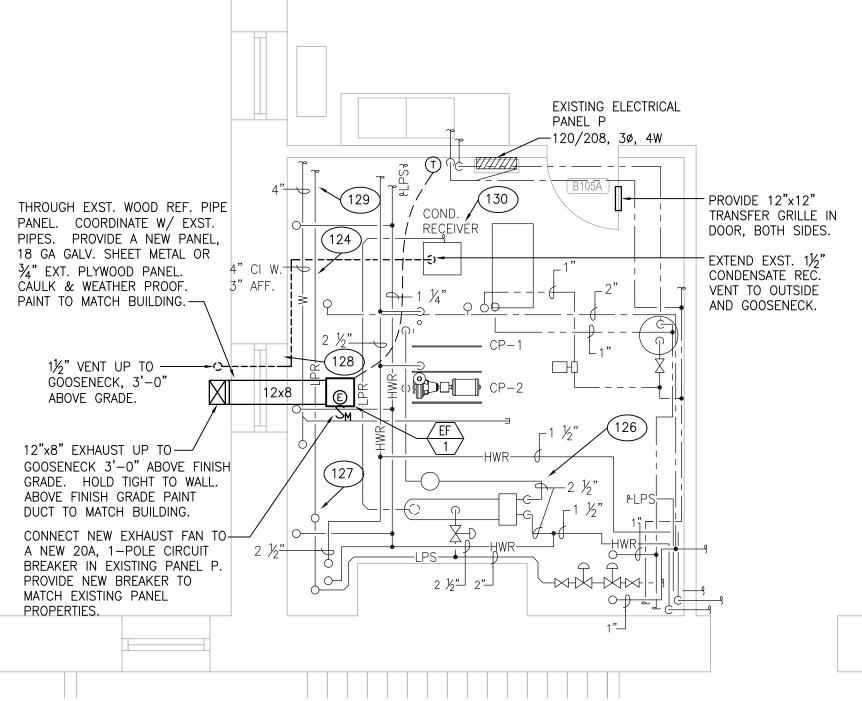
VA FORM 08-6231

C2 PHOTO 126
SCALE: NONE

C3 PHOTO 127
SCALE: NONE

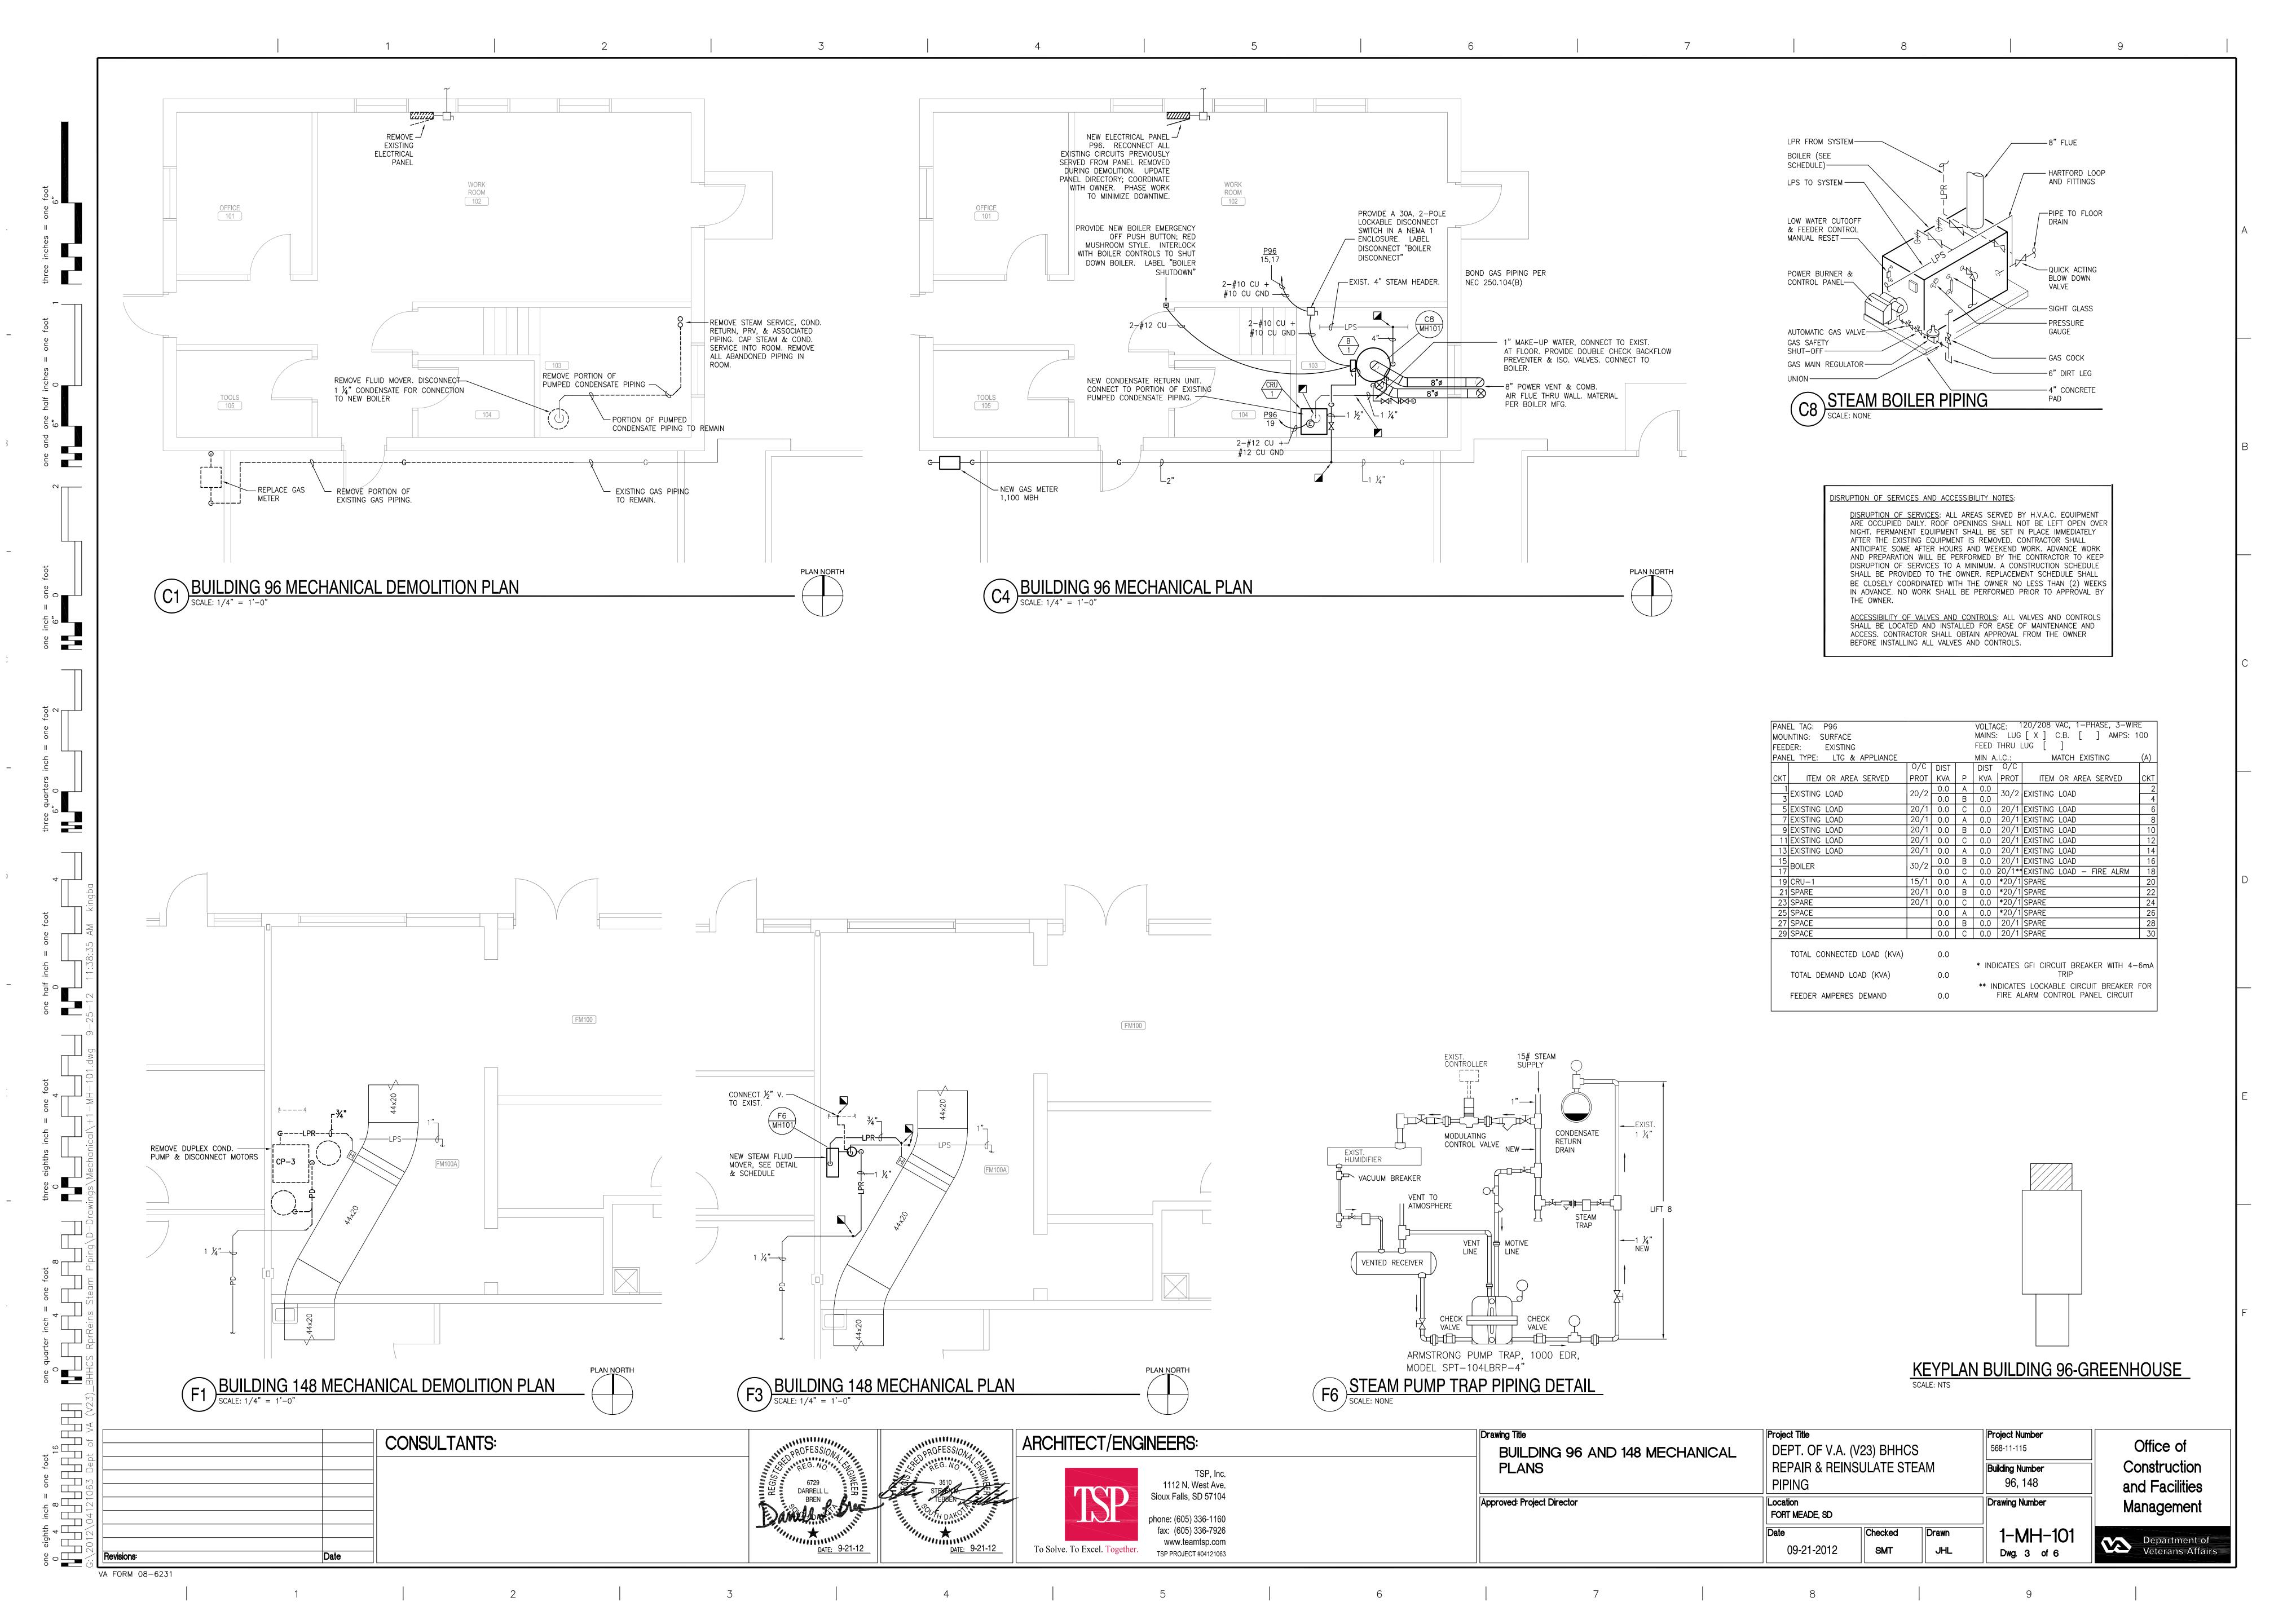C5 PHOTO 128
SCALE: NONE

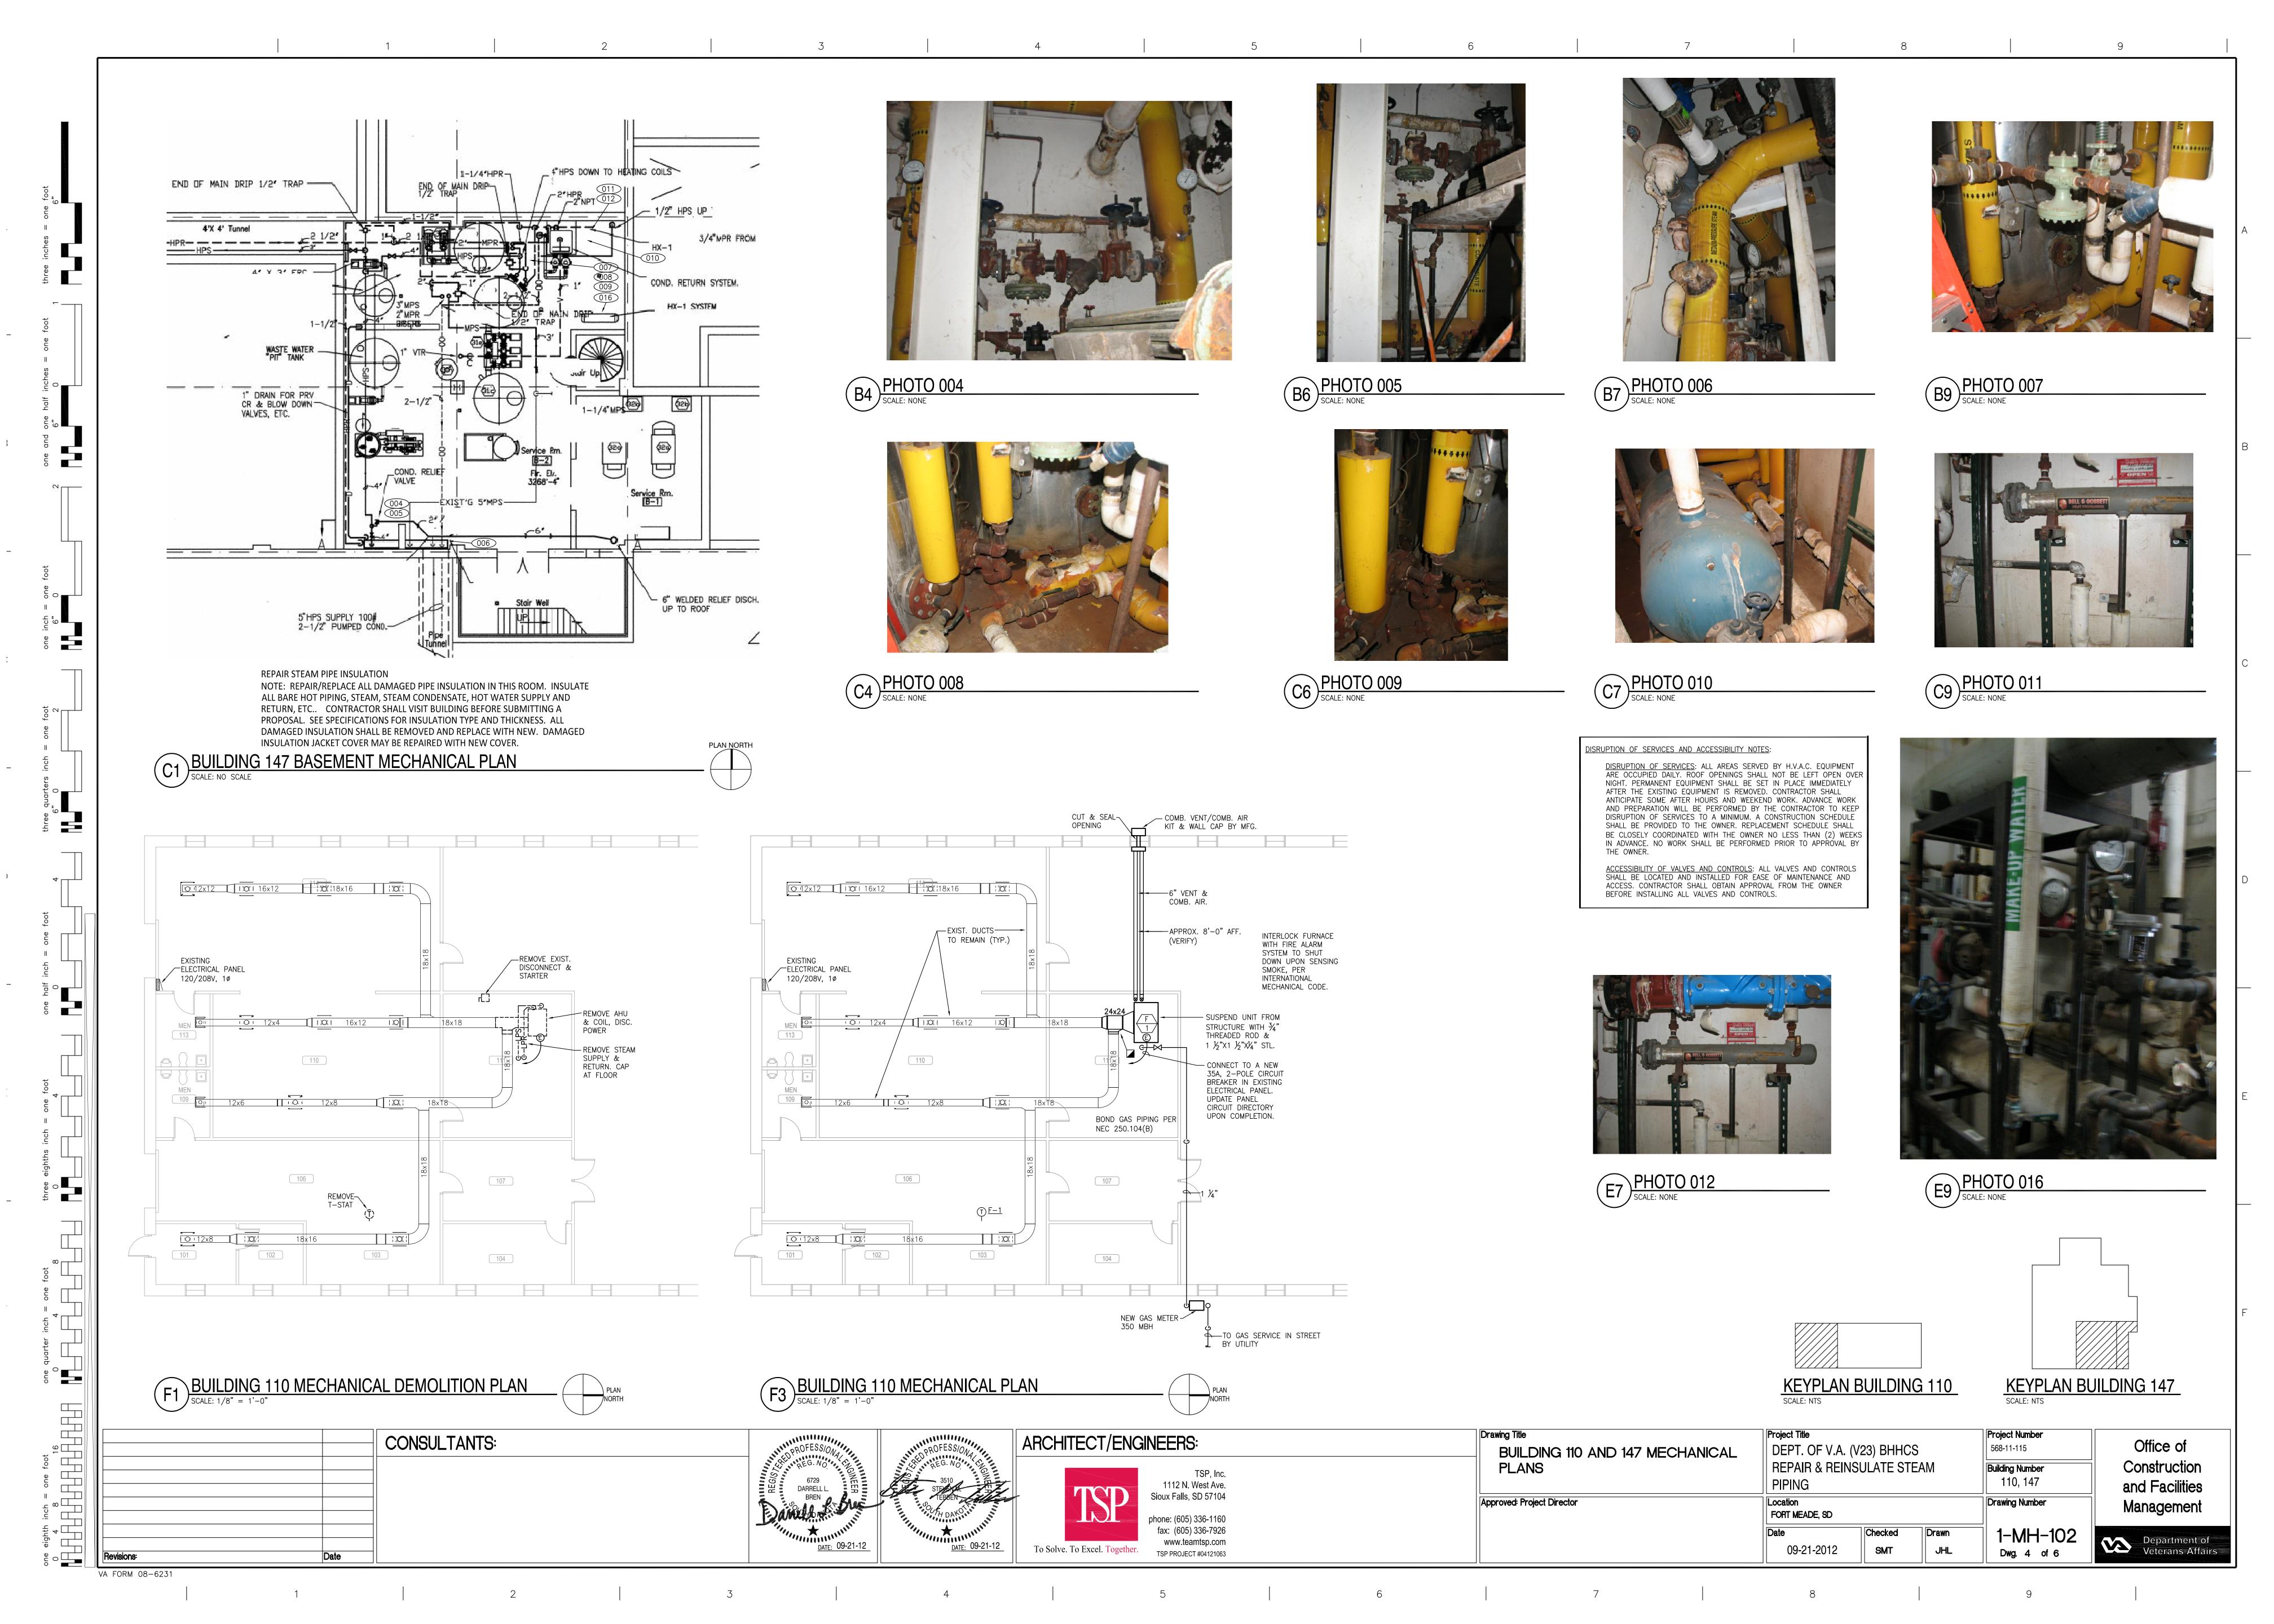C7 PHOTO 129
SCALE: NONE

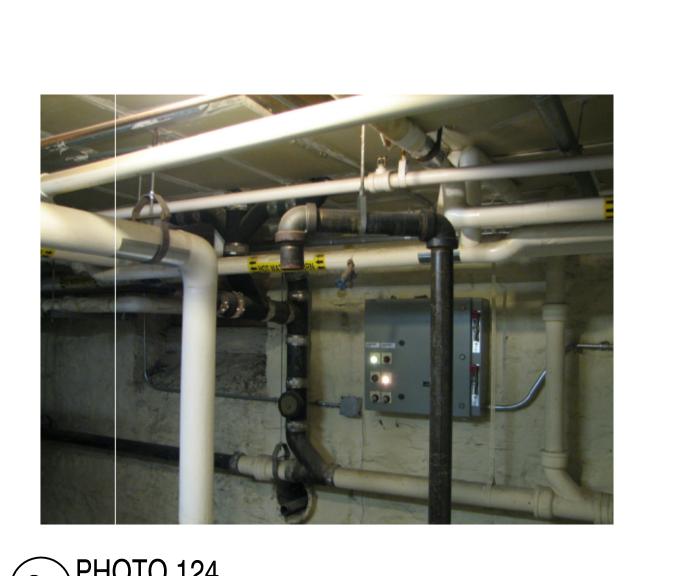

REPAIR STEAM PIPE INSULATION NOTE: REPAIR/REPLACE ALL DAMAGED PIPE INSULATION IN THIS ROOM. INSULATE ALL BARE HOT PIPING, STEAM, STEAM CONDENSATE, HOT WATER SUPPLY AND RETURN, ETC.. CONTRACTOR SHALL VISIT BUILDING BEFORE SUBMITTING A PROPOSAL. SEE SPECIFICATIONS FOR INSULATION TYPE AND THICKNESS. ALL DAMAGED INSULATION SHALL BE REMOVED AND REPLACE WITH NEW. DAMAGED INSULATION JACKET COVER MAY BE REPAIRED WITH NEW COVER.

REPLACE 10" STEAM VALVE, 2" BY-PASS VALVE AND REINSULATE








F5 BUILDING 148 RM. FM101
SCALE: NONE


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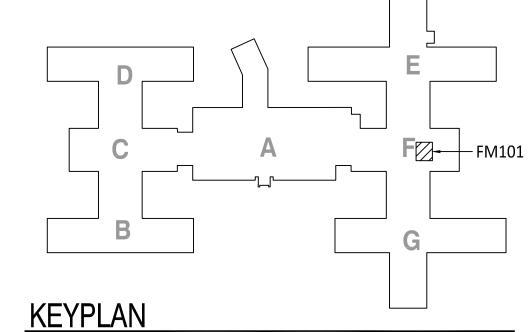
ACCESSIBILITY OF VALVES AND CONTROLS: ALL VALVES AND CONTROLS SHALL BE LOCATED AND INSTALLED FOR EASE OF MAINTENANCE AND ACCESS. CONTRACTOR SHALL OBTAIN APPROVAL FROM THE OWNER BEFORE INSTALLING ALL VALVES AND CONTROLS.

REPAIR STEAM PIPE INSULATION NOTE: REPLACE ALL STEAM PIPE INSULATION AT PRESSURE REDUCING STATION. INCLUDE HPS & LPS VERTICAL FROM 8' AFF. DN. TO FLOOR. VERIFY WORK & EXTENT BEFORE SUBMITTING PROPOSAL. INSULATE ALL VALVES & CV'S. SEE SPECIFICATIONS FOR INSULATION TYPE AND THICKNESS.





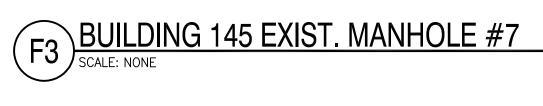

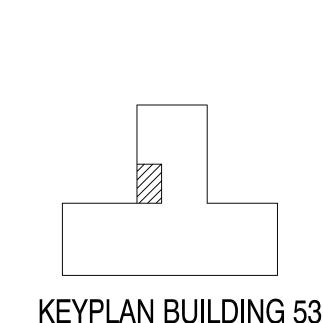

KEYPLAN BUILDING 53
SCALE: NTS

KEYPLAN
SCALE: NTS

JHL

CONSULTANTS:

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	PROFESS/ONAL PEG. NO.
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TSP, Inc. 1112 N. West Ave. Sioux Falls, SD 57104 phone: (605) 336-1160 fax: (605) 336-7926 www.teamtsp.com To Solve. To Excel. Together. TSP PROJECT #04121063

ARCHITECT/ENGINEERS:

PLANS Approved: Project Director

Drawing Title Project Title BUILDING 53, 145 AND 148 MECHANICAL DEPT. OF V.A. (V23) BHHCS REPAIR & REINSULATE STEAM PIPING Location

568-11-115 Building Number 53, 145, 148 Drawing Number

Office of Construction and Facilities Management

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FORT MEADE, SD

09-21-2012

Checked

SMT

1-MH-103 Dwg. 5 of 6

Project Number

Department of Veterans Affairs

FURNACE SCHEDULE ELECTRICAL REQUIREMENTS MECHANICAL REQUIREMENTS FURNACE REQUIREMENTS MANUFACTURER & | TOTAL | MIN. | EXT. | EAT LAT
 NO.
 LOCATION
 SERVES
 MODEL#
 CFM
 %O.A.
 SP (IN)
 FUEL
 % EFF.
 RPM
 HP
 IN
 OUT
 FILTERS
 (DEG. F)
 REMARKS
 VOLT/PH
 AMP
 SIZE
 TYPE
 SIZE
 LOCATION
 CNTRL. DVC.

 F-1
 BLDG 110
 -- REZNOR SCE-350
 5000
 0
 1
 NG
 80
 1160
 5
 350
 250
 DISP
 70
 110
 ALL
 208/1
 24
 #8
 INTEGRAL
 IN UNIT
 THERMOSTAT
 TYPE BY REMARKS SIZE LOCATION CNTRL. DVC. AUX. BY CONTROL MC TCC INTEGRAL MC MECH REMARKS: 1. UNIT SELECTED FOR 4,000 FT ELEVATION FILTER RACK 3. ELECTRIC MODULKATION 20% - 100% TURN DOWN 4. UNIT DISCONNECT SWITCH 5. VENT TERMINAL/COMBUSTION AIR KIT LOW PRESSURE STEAM BOILER SCHEDULE ELECTRICAL REQUIREMENTS MECHANICAL REQUIREMENTS MANUFACTURER & OPERATING N.G. MBH MBH MIN. GAS BLOWER MECH PRESSURE (PSIG) INPUT OUTPUT PRESS (INCI WC) MOTOR HP. REMARKS VOLT/PH AMP LOCATION MODEL# TYPE SIZE LOCATION CNTRL. DVC. AUX. BY CONTROL 700.0 589.0 1,2,3,4,5 | 120/1 | – #10 | INTEGRAL | IN UNIT INTEGRAL TCC NFD DIV 26 E1 BLDG 96 GREENHOUSE TRIAD SERIES 600 GMS 0.5 MC MECH REMARKS: 1. SEE SPECIFICATION FOR, BURNER DESCRIPTION. NOTE POWER AVAILABLE. E1. PROVIDE A 30A, 2-POLE, LOCKABLE DISCONNECT SWITCH IN NEMA 1 ENCLOSURE. 2. CONTROL PANEL SHALL BE SINGLE POINT POWER CONNECTION CONTAINING TRANSFFORMER NEEDED FOR CONTROLS AND BLOWER. 3. PROVIDE ALL ASME CONTROLS, SAFETY DEVICES, VALVES AND TRIM AS REQUIRED FOR A COMPLETE OPERATING SYSTEM. 4. BOILER SHALL COMPY WITH SD BOILER INSPECTION, RULES AND GREGULATIONS. 5. MC SHALL PROVIDE STEAM SUPPLY AND CONDENSATE RETURN VALVES AT THE BOILER. **EXHAUST FAN & POWER ROOF VENT SCHEDULE** MECHANICAL REQUIREMENTS ELECTRICAL REQUIREMENTS MANUFACTURER & BY REMARKS NO. LOCATION CFM H20 SONES RPM HP VOLT/PH AMP TYPE SIZE LOCATION CNTRL. DVC. AUX. BY MODEL NO. 1,2,3 120/1 | 2.6 | #12 | EF-1 | CEILING |BLDG 53, RM B105A MMS - AT UNIT T-STAT - EC T-STATCOOK GN-620 400 | 0.25 | 1.0 | 950 |245W| INTEGRAL MC MECH REMARKS: PROVIDE BD DAMPER

2. PROVIDE UNIT MOUNT DISCONNECT 3. CONTROL BY THERMOSTAT LOCATED IN ROOM. PROVIDE THERMOSTAT CONTROLLED RELAY IN POWER CIRCUIT TO FAN.

CONDENSATE RETURN UNIT SCHEDULE MECHANICAL REQUIREMENTS ELECTRICAL REQUIREMENTS TYPE CAPACITY GPM DISCHARGE MOTOR MOTOR SIZE TYPE INLET CONTROL DESIG. LOCATION MANUFACT. MECH WIRE TYPE SIZE LOCATION CNTRL. DVC. AUX. BY CONTROL TYPE BY REMARKS REMARKS VOLT/PH AMP SIZE PRESS PSI RPM HP CRU-1 BLDG 96 RM 103 DOMESTIC PUMP 121.5CS DUPLEX 1000 6.00 15 1750 1/3 23 CI 2 LWCO SEE NOTES 120/1 9 #12 INTEGRAL - AT UNIT - - MC TCC INTEGRAL MC

MECH REMARKS: 1. PROVIDE 3/4 INCH MAKEUP WATER FLOAT CONTROL AND CONNECTION.

2. EXTEND 2 INCH VENT THROUGH WALL AND UP TO GOOSENECK. HOLD TIGHT OT BUILDING.

3. CONNECT PUMP CONTROL TO BOILER MAKEUP WATER CONTROL

4. PROVIDE ALTERNATOR CONTROL PANEL WITH INTEGRAL DISCONNECTS.

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1			TSP, Inc. 1112 N. West Ave.		REPAIR & REINSULATE STEAM PIPING	Building Number 96,110	Construction and Facilities
04121(STERREN Sioux Falls, SD 57104 phone: (605) 336-1160	Approved: Project Director	Location FORT MEADE, SD	Drawing Number	Management
72102	Revisions: Date		DATE: 9-21-12 To Solve. To Excel. Together. fax: (605) 336-7926 www.teamtsp.com TSP PROJECT #04121063		DateCheckedDrawn09-21-2012SMTJHL	1-ME601 Dwg. 6 of 6	Department of Veterans Affairs

VA FORM 08-6231

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